Minnehaha Creek Watershed District

REQUEST FOR BOARD ACTION

MEETING DATE:	December 3, 2019								
TITLE:	• •	Approval of plans and specifications and authorization to solicit quotes for carp barrier construction in the Six Mile Creek-Halsted Bay Subwatershed							
RES. NUMBER:	19-102	19-102							
PREPARED BY:	Anna Brown								
E-MAIL: abrown@minnehahacree		hacreek.c	org	TELEPHONE: (952) 641-4522					
REVIEWED BY:	□Administrator □ Board Committee	☐ Counsel ☐ Engineer		☑ Program Mgr.: Michael Hayman ☐ Other					
WORKSHOP ACTION:									
☐ Advance to Board mtg. Consent Agenda.				☐ Advance to Board meeting for discussion prior to action.					
☐ Refer to a future workshop (date):			☐ Refer to taskforce or committee (date):						
☐ Return to staff for additional work.			☐ No further action requested.						
☐ Other (specify): Requesting final action December 3, 2019									
1									

PURPOSE or ACTION REQUESTED:

Approval of plans and specifications for carp barriers located in the Six Mile Creek-Halsted Bay Subwatershed (SMCHB) and authorization to solicit quotes for construction services.

PROJECT/PROGRAM LOCATION:

West Auburn Lake, Carver Park Reserve

PROJECT TIMELINE:

October 2017 MCWD recommended for funding through Lessard Sams Outdoor Heritage Fund

March 2018 Barrier design contract awarded

Winter 2018/19 First three barriers installed at Highland Road, Crown College, and Wassermann Lake

December 2019 Final design for Auburn/Lundsten Barrier

January 2019 Contract award

Spring 2019 Construction complete

PROJECT/PROGRAM COST:

Fund name and number: 500-5007 SMCHB Carp Management

Current Budget: \$567,000

Requested amount of funding: \$0

PAST BOARD ACTION:

May 11, 2017 Authorization to request funding from Lessard Sams Outdoor Heritage Council (17-036)

March 8, 2018 Award contract for carp barrier design (18-021)

SUMMARY:

In September of 2017, the Lessard Sams Outdoor Heritage Council recommended the Six Mile Creek-Halsted Bay (SMCHB) Habitat Restoration Project for \$567,000 to the Minnesota State Legislature. The funding bill was approved by the legislature and the grant period began on July 1, 2018.

The program takes a holistic and comprehensive approach to managing common carp in the SMCHB Subwatershed based on the University of Minnesota's SMCHB carp assessment (2014-2017), which developed a carp population census for each waterbody, identified migration patterns between waterbodies, and identified likely reproduction areas. To address the carp population holistically, the University researchers worked with District staff to develop a management approach, consisting primarily of three management strategies:

- Adult biomass removal
- Aeration of shallow lakes to prevent successful carp reproduction
- Barriers to prevent carp movement between waterbodies and assist with removal

Consistent with the accomplishment plan approved by the Lessard Sams Outdoor Heritage Council, the grant funds will be used to pay for the capital cost of barrier installation, utility installation for aeration, and the fish removal contracts. The District match includes equipment for removal and monitoring, the aeration units, and design services.

In March of 2018, the MCWD Board of Managers awarded a contract with Wenck Associates to design barriers at four locations. The first three barriers – Wassermann, Crown College, and Highland Road – were designed in 2018 and constructed in the winter of 2019. The fourth location, at the outlet of West Auburn Lake, will be constructed this winter.

Upon approval of the plans and specifications, the quote package will be finalized and released in early December 2019. The contract award will be brought before the Board on January 9, 2020.

The Lessard Sams funding allocated for this project is \$30,000.

ATTACHMENTS:

Lake Auburn Carp Barrier Plan Set

RESOLUTION

RESOLUTION NUMBER: 19-102						
TITLE:	Approval of plans and specifications and authorization to solicit quotes for carp barrier construction in the Six Mile Creek-Halsted Bay Subwatershed					
WHEREAS,	pursuant to Resolution 14-047 the MCWD Board of Managers has identified the Six Mile Creek-Halsted Bay (SMCHB) Subwatershed as a priority area for focusing District planning activities and coordination efforts with subwatershed partners; and					
WHEREAS,	on October 10, 2013, the MCWD Board of Managers authorized the execution of a contract with Dr. Peter Sorenson and the University of Minnesota to conduct a three-year carp assessment of the SMCHB subwatershed which facilitated the development of a carp management strategy for the subwatershed; and					
WHEREAS,	beginning in 2016, MCWD led in the development of a comprehensive restoration strategy for the SMCHB subwatershed to achieve the District's goals of protecting and improving water quality, water quantity, ecological integrity, and thriving communities through land use and water integration, and includes rough fish management as a principle strategy for restoration;					
WHEREAS,	in September 2017, the Lessard Sams Outdoor Heritage Council recommended the SMCHB Habitat Restoration project for \$567,000 in funding, and in May of 2018 the funding was approved by the Minnesota Legislature;					
WHEREAS,	in March 2018, the MCWD Board of Managers authorized a contract with Wenck Associates to complete barrier design, including the development of plans and specification, and facilitation of the quote process for construction services for four carp barriers;					
WHEREAS,	in winter 2018/2019 the first three carp barriers were installed at Highland Road, Crown College, and the Lake Wassermann outlet, and the construction of the fourth barrier will follow the standard design established through that design and construction process;					
NOW, THERE	EFORE, BE IT RESOLVED, that the Minnehaha Creek Watershed District Board of Managers hereby approves plans and specifications for barrier construction at the outlet of West Auburn Lake; and					
BE IT FURTHER RESOLVED that the MCWD Board of Managers authorizes staff to solicit quotes for construction.						

_____ Date:____

Resolution Number 19-102 was moved by Manager ______, seconded by Manager _____ Motion to adopt the resolution ____ ayes, ____ nays, ___abstentions. Date: December 3, 2019.

Secretary




MINNEHAHA CREEK WATERSHED DISTRICT 15320 MINNETONKA BLVD MINNETONKA, MN 55345 (P) - 952-471-0590 CONTACT: ANNA BROWN


ENGINEER




WENCK ASSOCIATES, INC.
7500 OLSON MEMORIAL HWY
SUITE 300
GOLDEN VALLEY, MN 55427
(P) - 763-252-6800
CONTACT: CHRIS MEEHAN, P.E.

SITE CONSTRUCTION PLANS FOR LAKE AUBURN CARP BARRIER PREPARED FOR MINNEHAHA CREEK WATERSHED DISTRICT

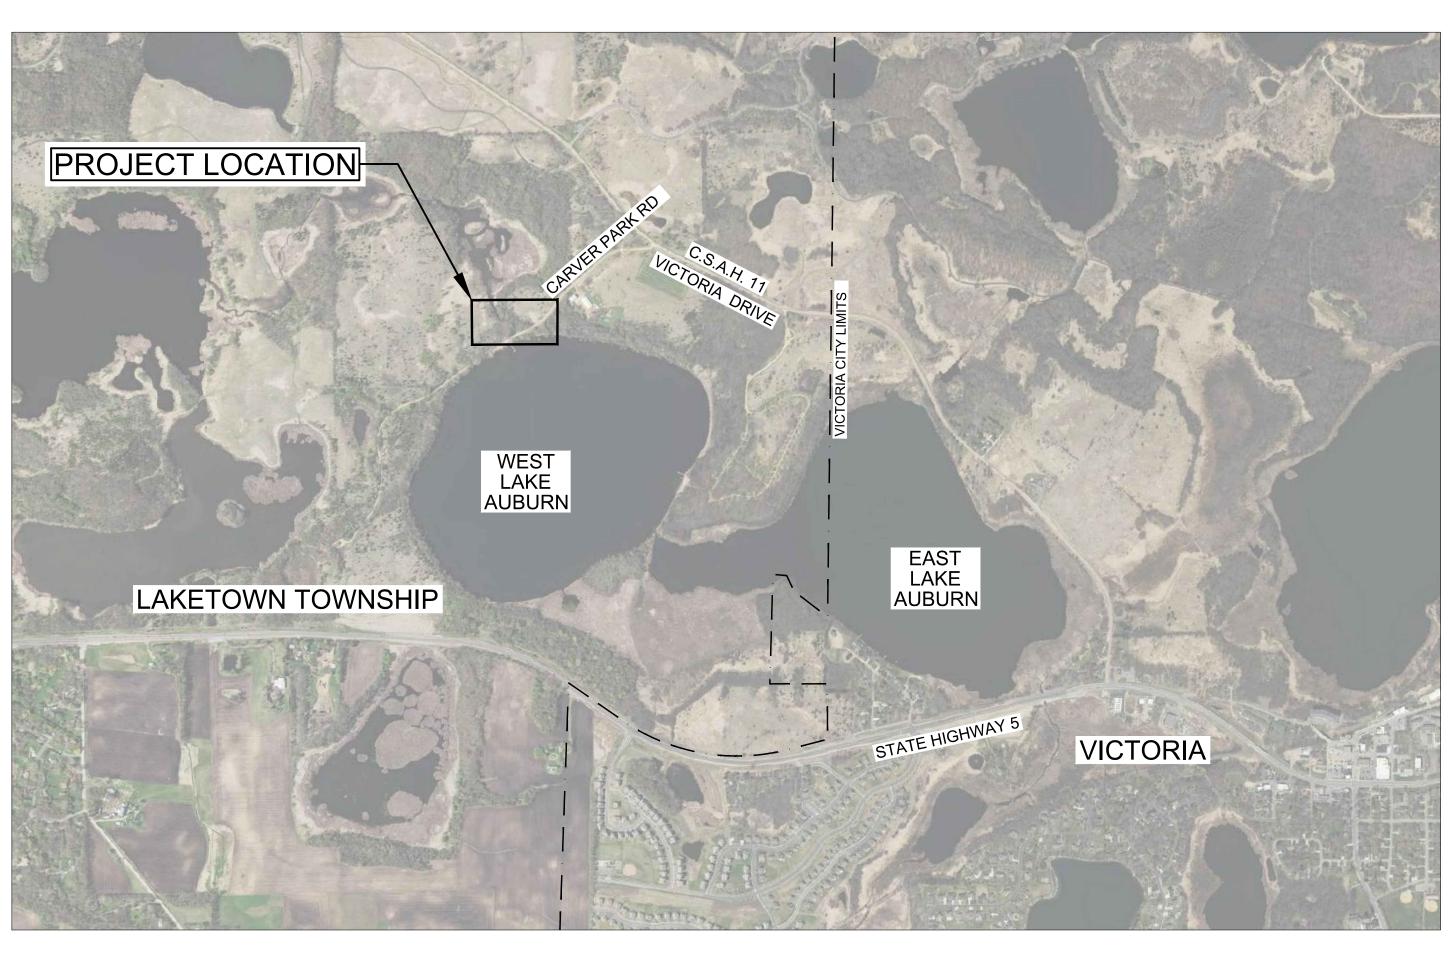

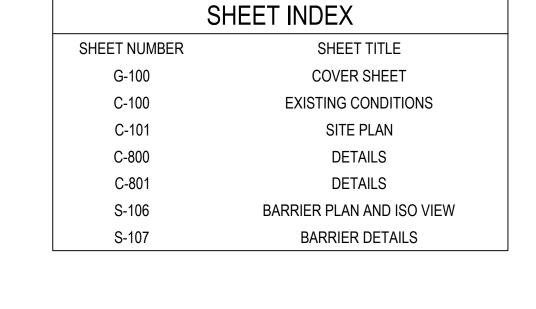

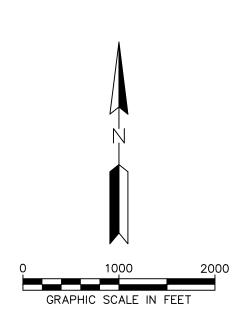

VICINITY MAP



NEAREST CITY: VICTORIA, MN COUNTY: CARVER

WARNING


THE CONTRACTOR SHALL BE RESPONSIBLE FOR CALLING FOR LOCATIONS OF ALL EXISTING UTILITIES. THEY SHALL COOPERATE WITH ALL UTILITY COMPANIES IN MAINTAINING THEIR SERVICE AND/OR RELOCATION OF LINES.

THE CONTRACTOR SHALL CONTACT GOPHER STATE ONE CALL AT 651-454-0002 AT LEAST 48 HOURS IN ADVANCE FOR THE LOCATIONS OF ALL UNDERGROUND WIRES, CABLES, CONDUITS, PIPES, MANHOLES, VALVES OR OTHER BURIED STRUCTURES BEFORE DIGGING. THE CONTRACTOR SHALL REPAIR OR REPLACE THE ABOVE WHEN DAMAGED DURING CONSTRUCTION AT NO COST TO THE OWNER.

CALL BEFORE YOU DIG

GOPHER STATE ONE CALL

TWIN CITY AREA: 651-454-0002 TOLL FREE 1-800-252-1166

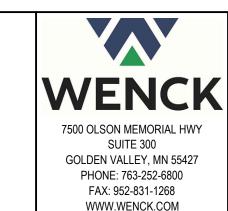

MINNEHAHA CREEK
WATERSHED DISTRICT
QUALITY OF WATER, QUALITY OF LIFE



AKE AUBURN ARP BARRIER

CRIPTION: ISSUE#

CERTIFICATION:

I HEREBY CERTIFY THAT THIS PLAN,
SPECIFICATION OR REPORT WAS

I HEREBY CERTIFY THAT THIS PLAN SPECIFICATION, OR REPORT WAS PREPARED BY ME OR UNDER MY DIRECT SUPERVISION AND THAT HAM A DULY REGISTERED PROFESSIONAL ENGINEER UNDER THE CAUSE OF THE STATE OF MINNESOT

LICENSE NO.:

PROJECT NO.: PROJECT #

DWN BY: CHK'D BY: APP'D BY:
MJK ERM CJM


ISSUE DATE: DATE

ISSUE#

SHEET TITLE:

COVER SHEET

G-100

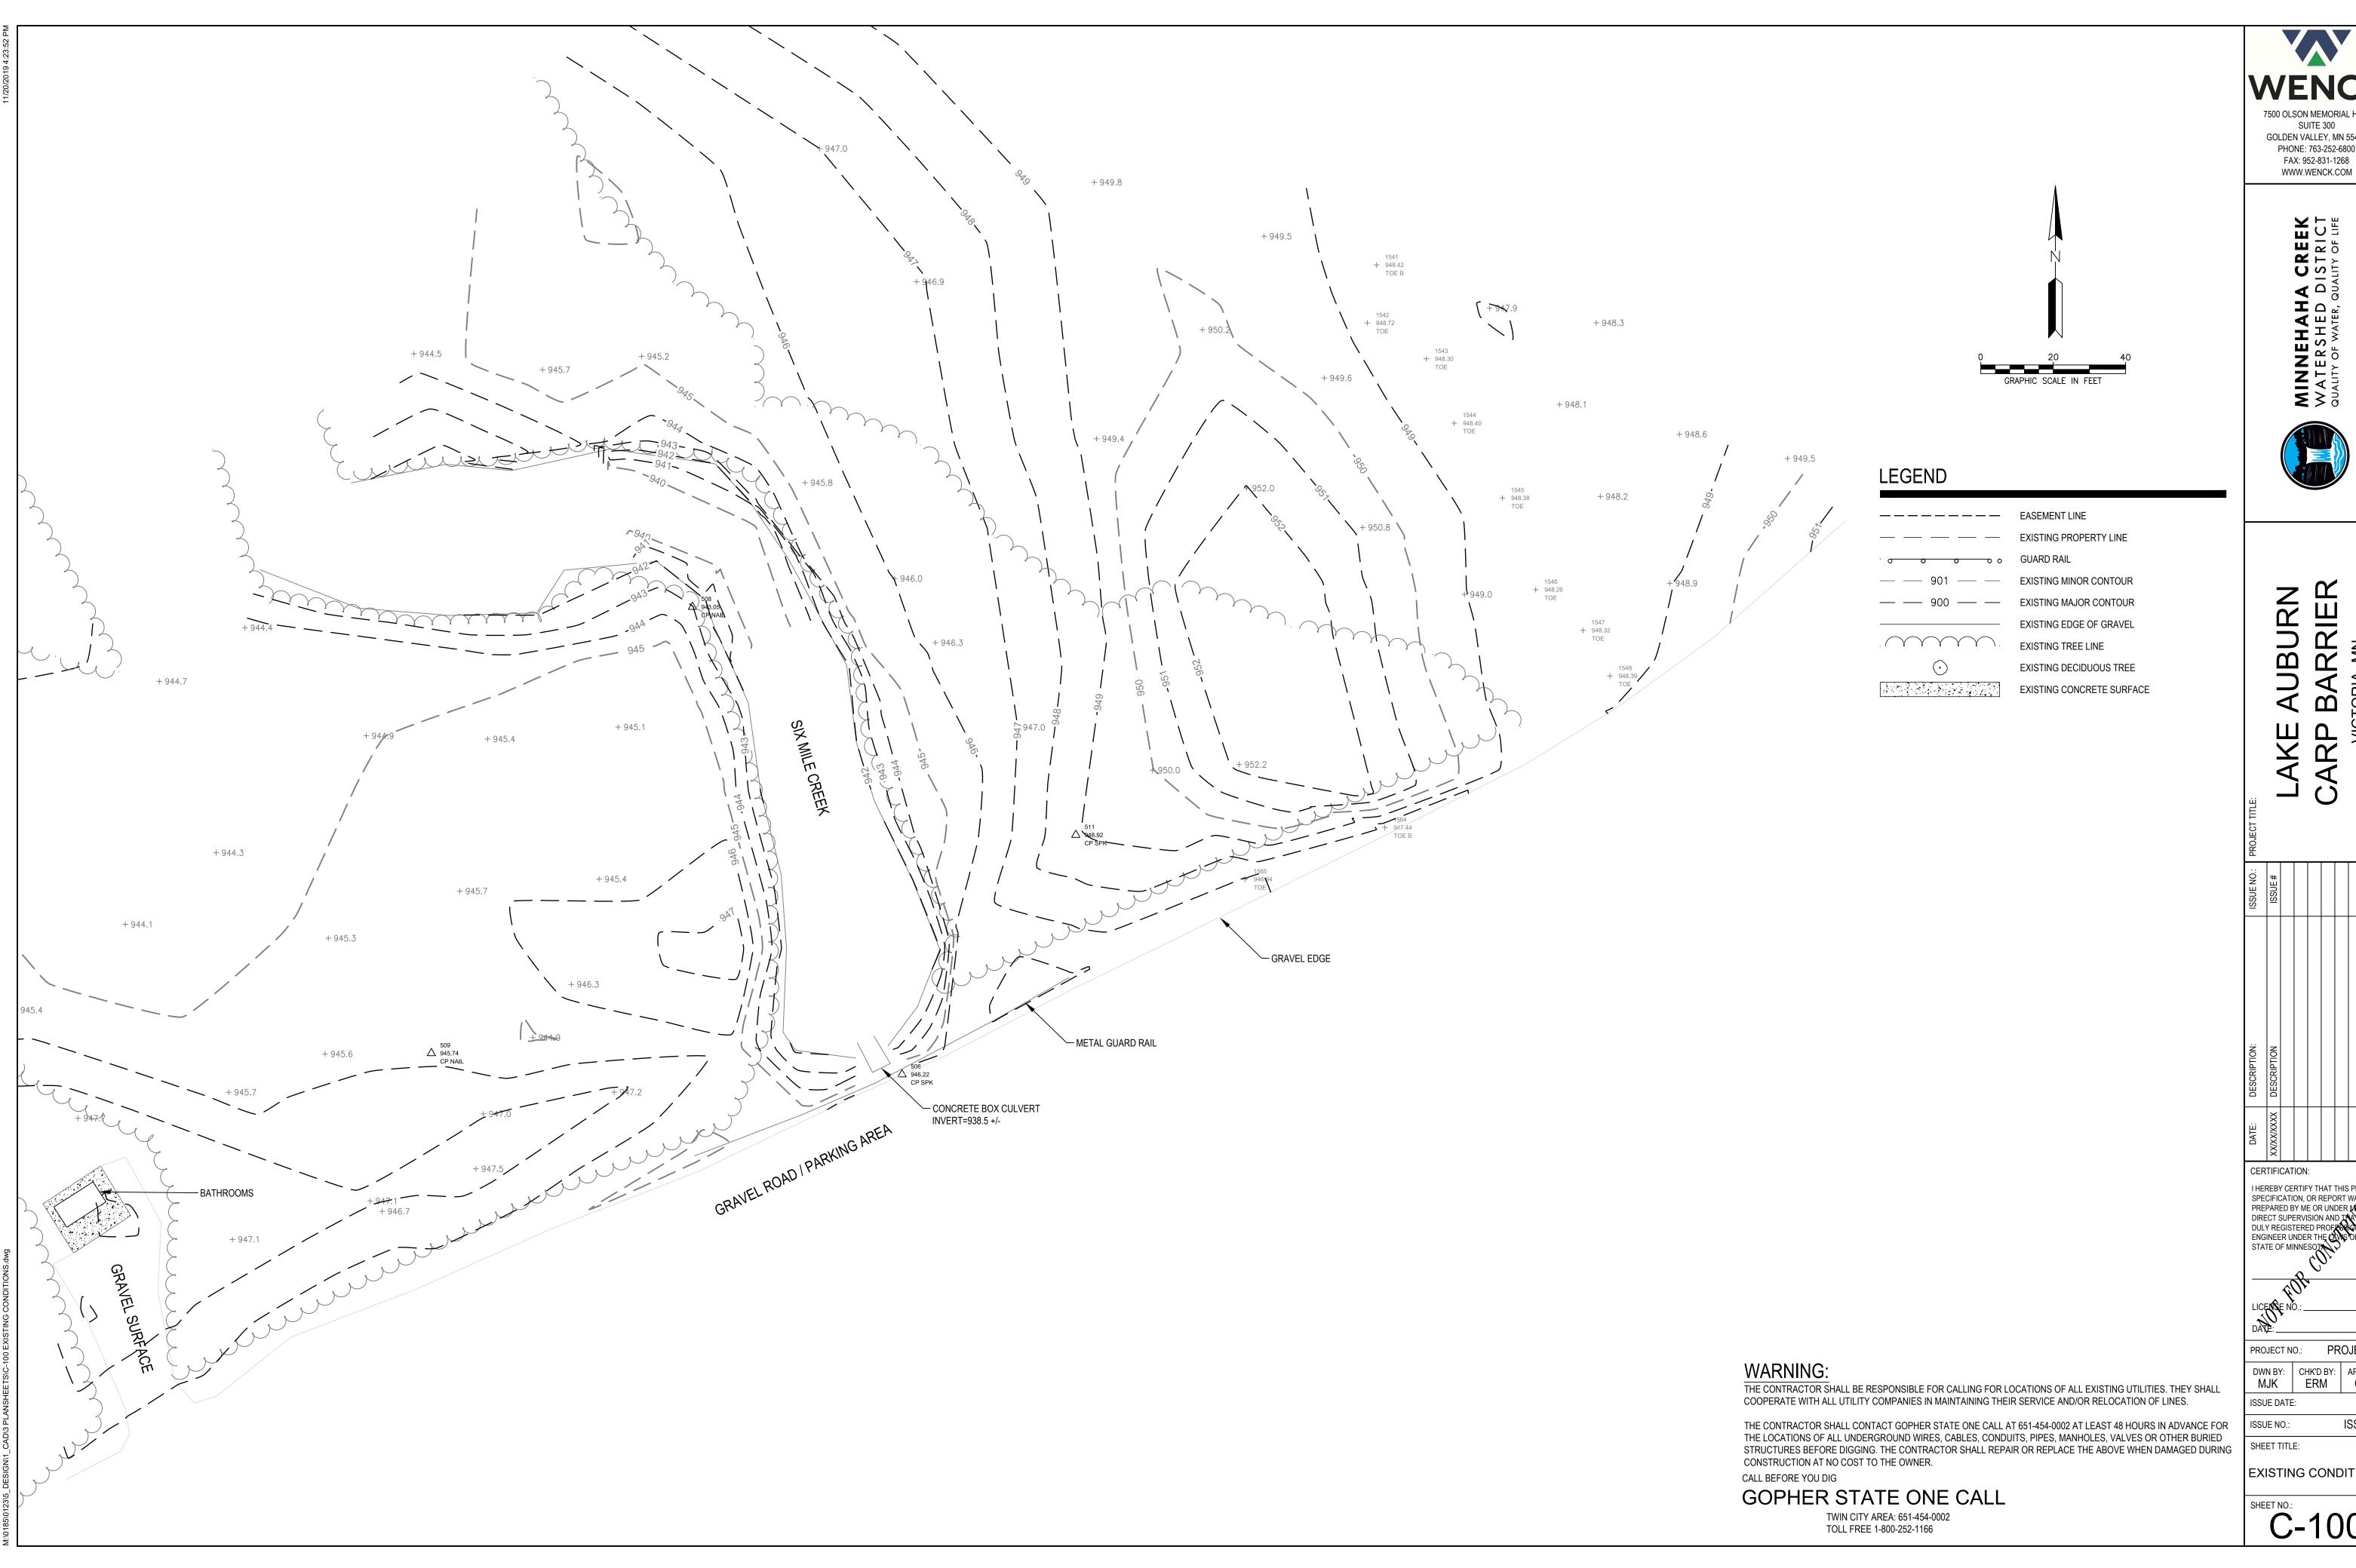

7500 OLSON MEMORIAL HWY SUITE 300 GOLDEN VALLEY, MN 55427 PHONE: 763-252-6800 FAX: 952-831-1268



AUBURN BARRIER


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SPECIFICATION, OR REPORT WAS
PREPARED BY ME OR UNDER MY
DIRECT SUPERVISION AND THAT AM A
DULY REGISTERED PROFESSIONAL
ENGINEER UNDER THE CANS OF THE
STATE OF MINNESOTA

PROJECT NO.: PROJECT #

DWN BY: CHK'D BY: APP'D BY: MJK ERM CJM DATE ISSUE#

EXISTING CONDITIONS

SHEET NO.:
C-100

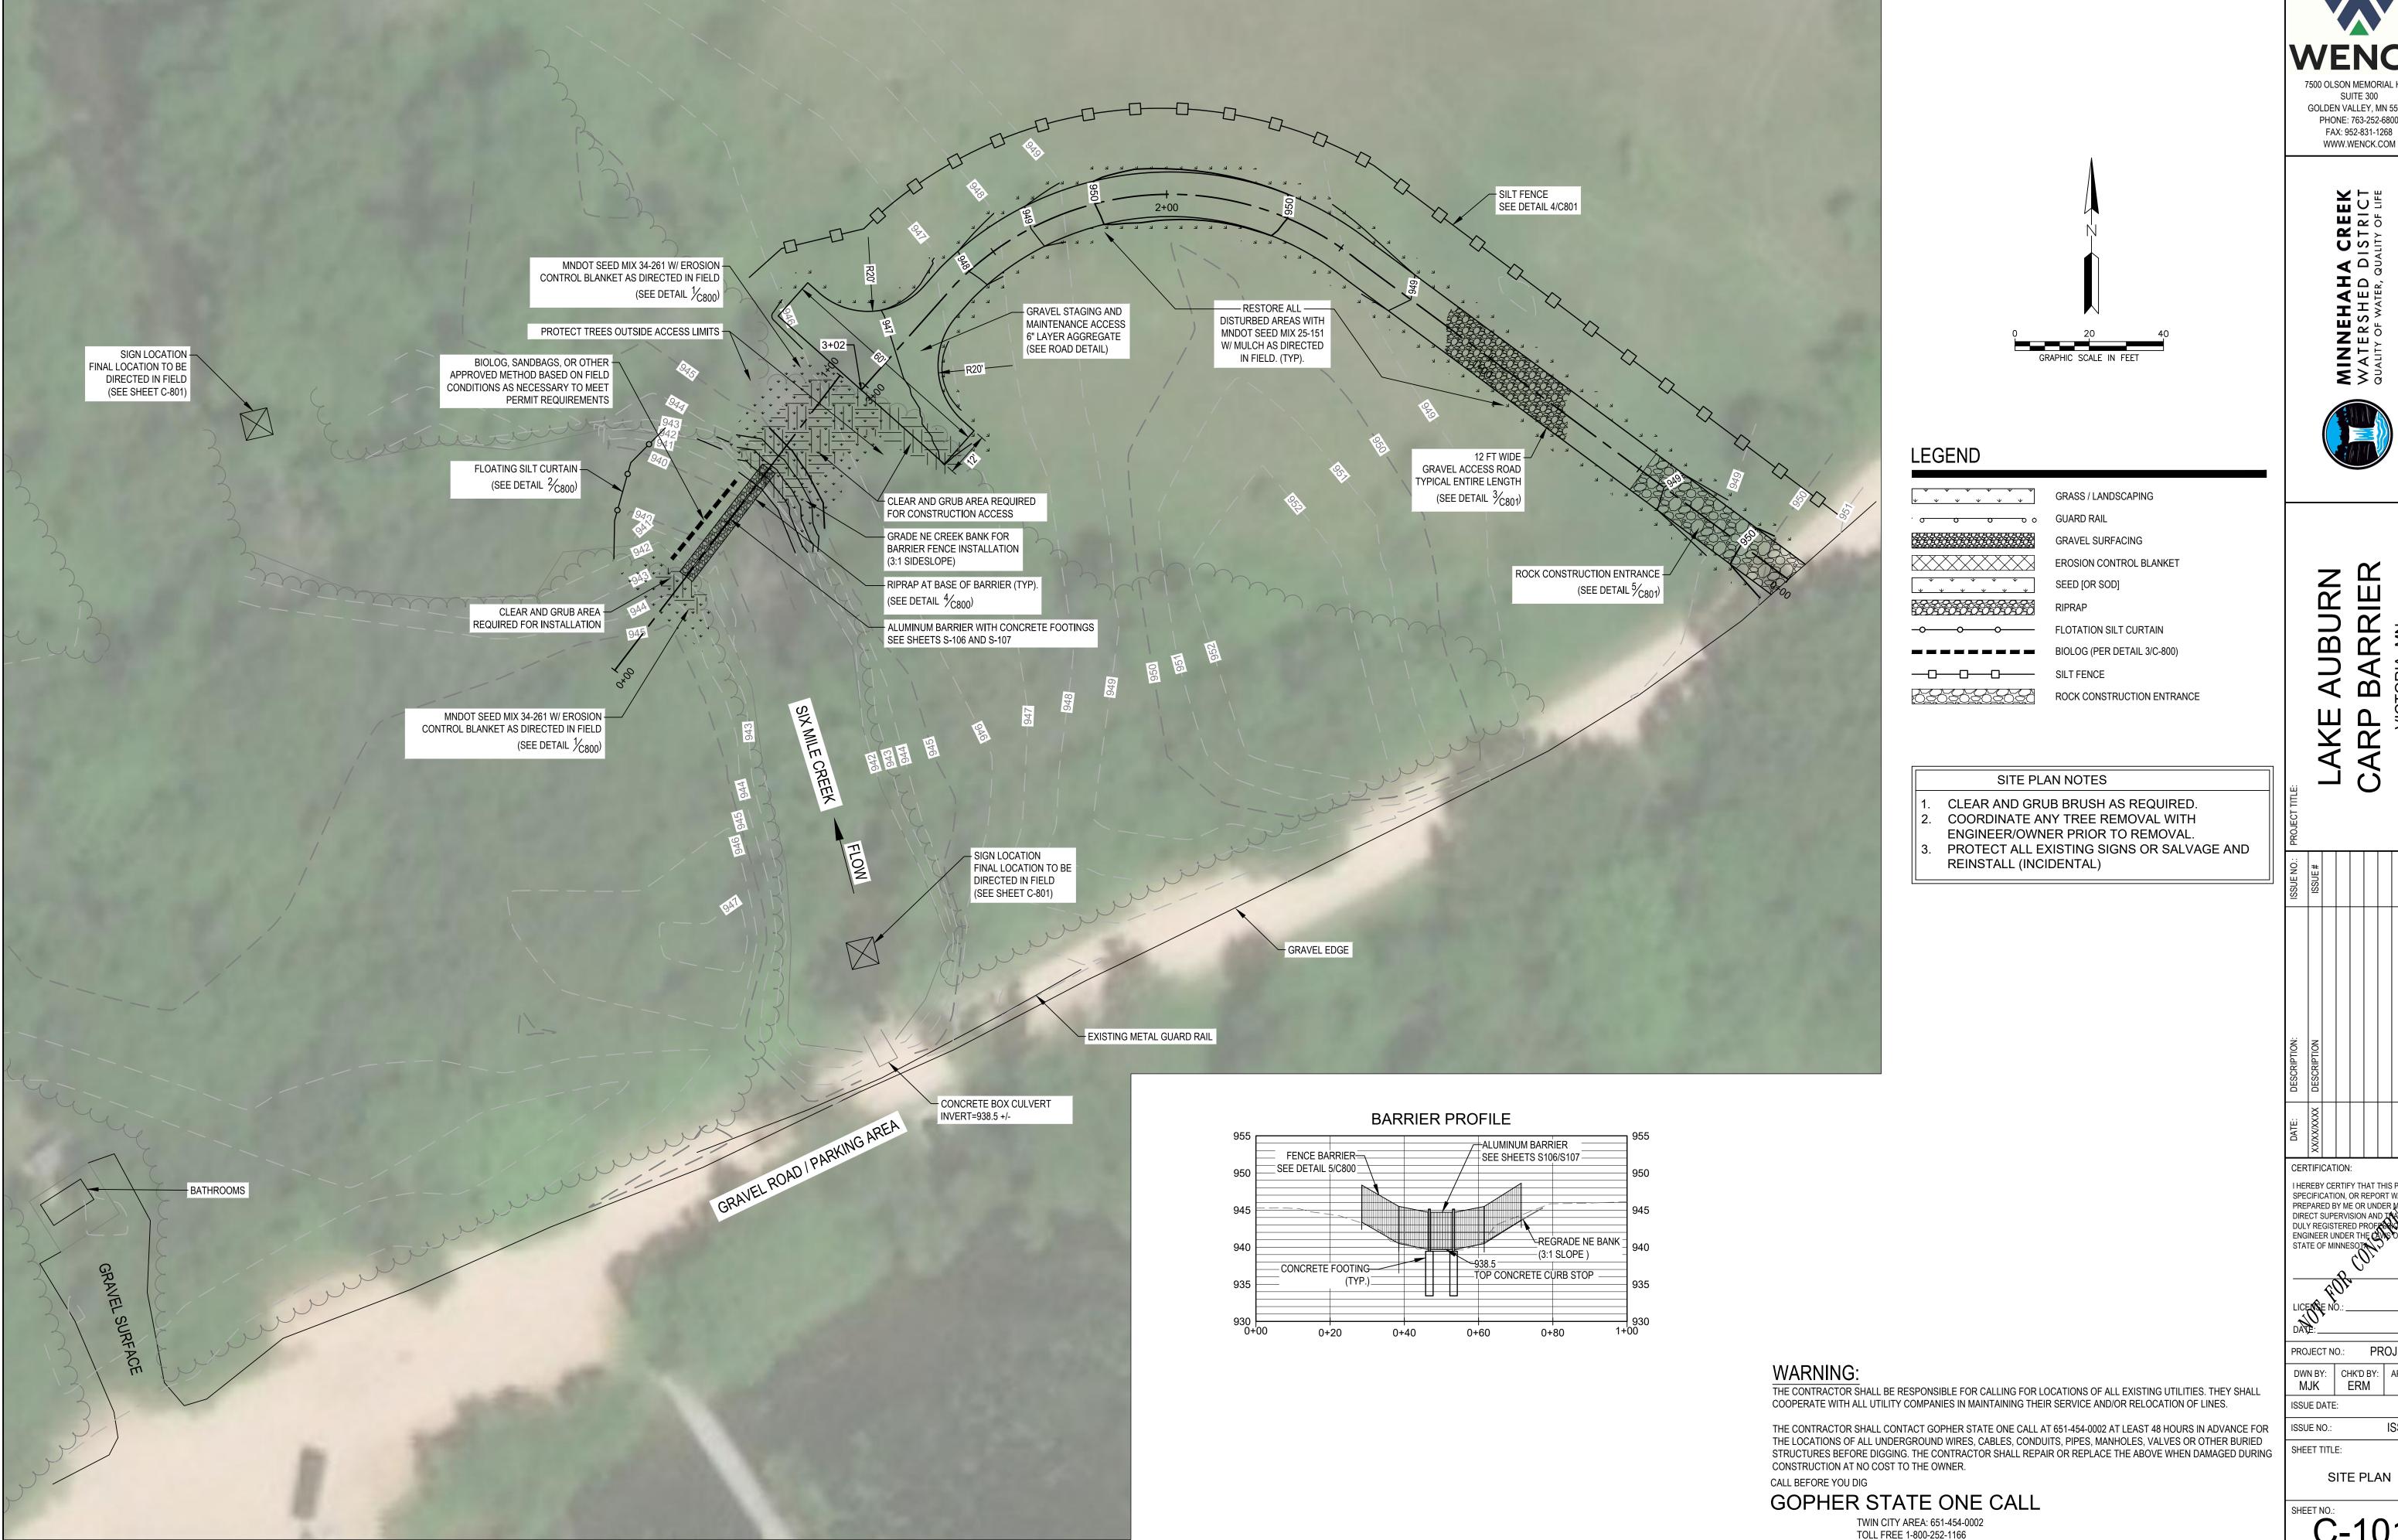

7500 OLSON MEMORIAL HWY SUITE 300 GOLDEN VALLEY, MN 55427 PHONE: 763-252-6800 FAX: 952-831-1268



NABURN SARRIER


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STATE OF MINNESOT

PROJECT NO.: PROJECT # DWN BY: CHK'D BY: APP'D BY: MJK ERM CJM

ISSUE DATE: ISSUE # ISSUE NO.:

SHEET TITLE: SITE PLAN

C-101

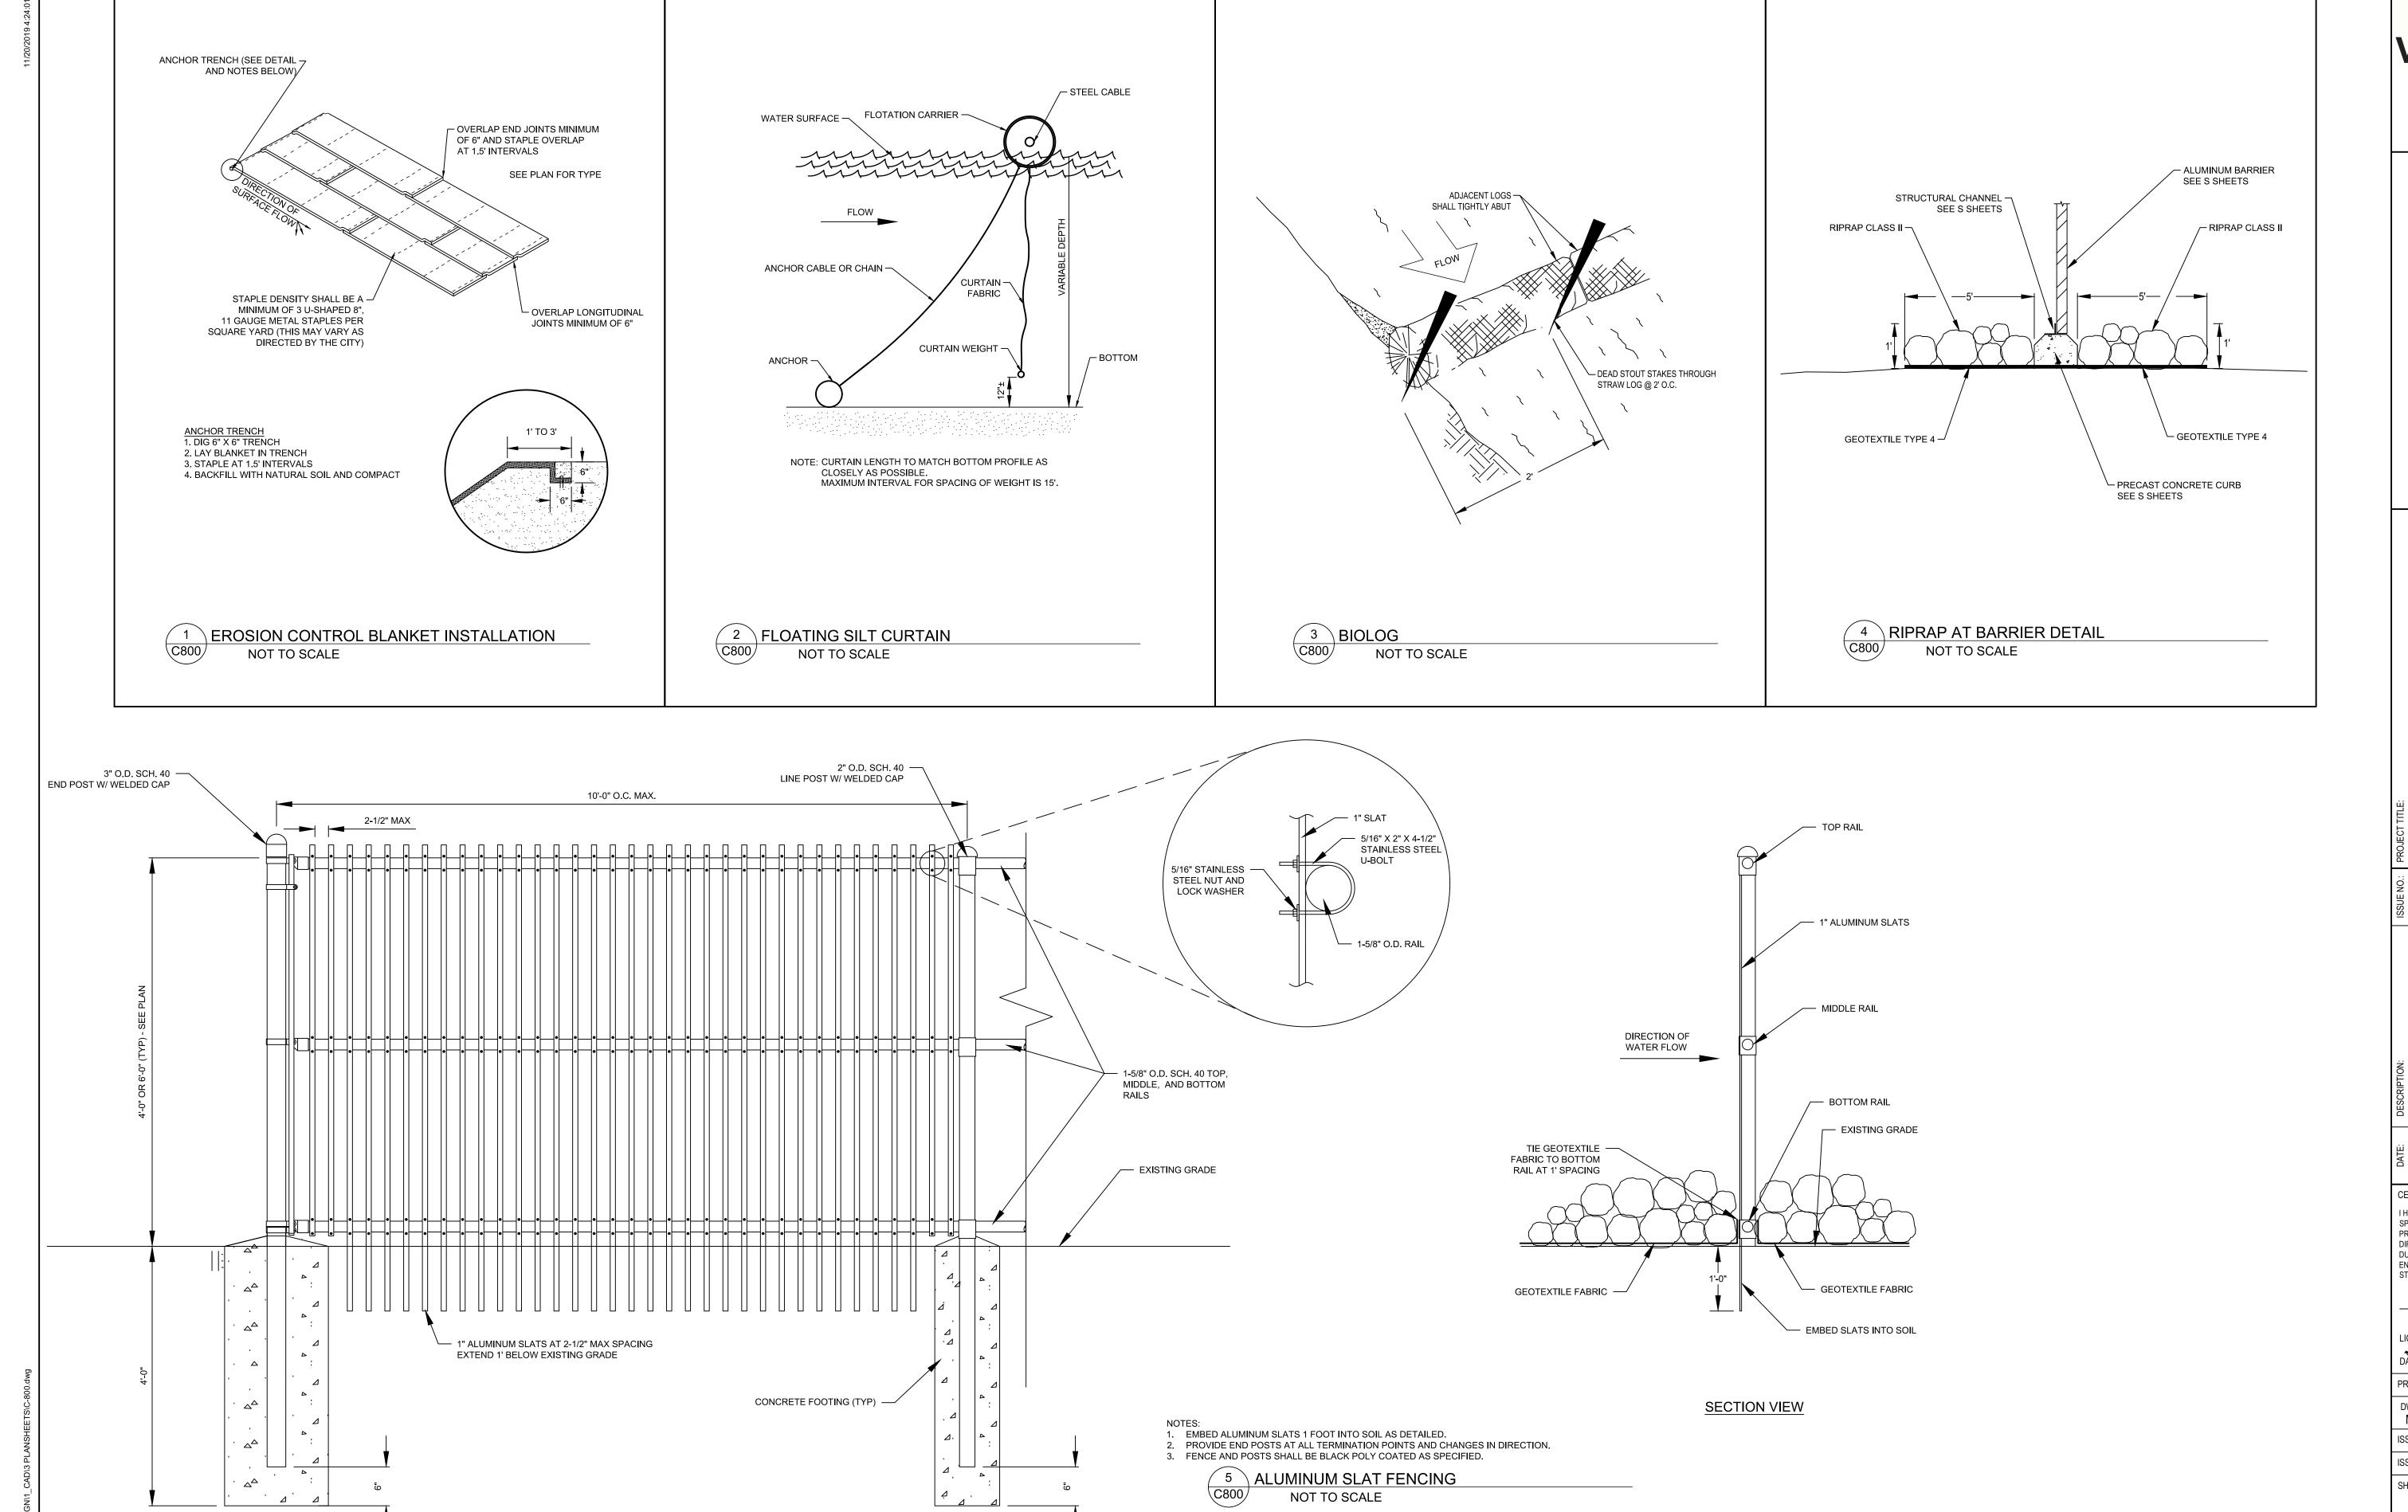

WENCK

7500 OLSON MEMORIAL HWY SUITE 300 GOLDEN VALLEY, MN 55427 PHONE: 763-252-6800 FAX: 952-831-1268 WWW.WENCK.COM

> AINNEHAHA CREEK VATERSHED DISTRICT UALITY OF WATER, QUALITY OF LIFE



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(X/XX/XXXX DESCRIPTION ISSUE # ISSUE

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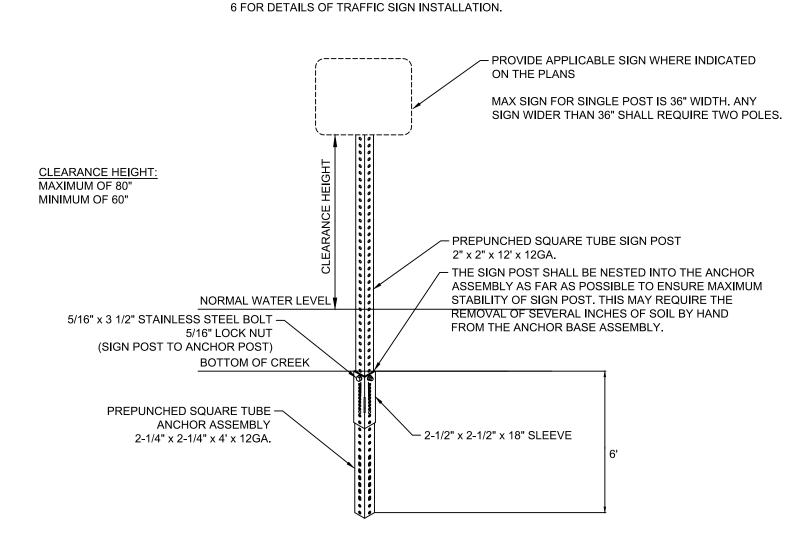
ISSUE NO.: ISSUE #

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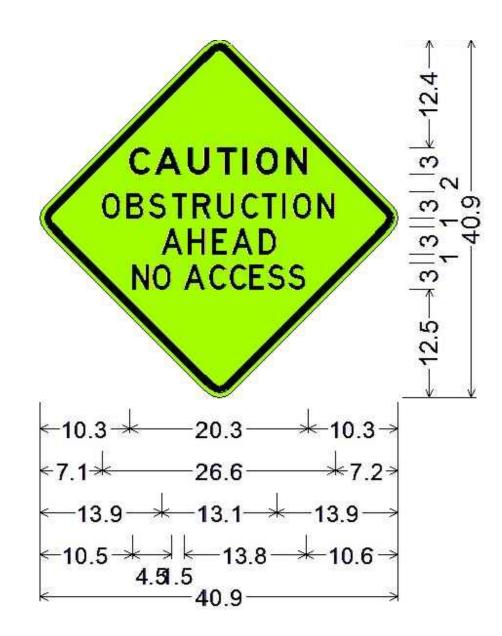
DETAILS

C-800

SEE MnDOT TRAFFIC ENGINEERING MANUAL CHAPTER









30.0" across sides 1.9" Radius, 0.8" Border, 0.5" Indent, Black on Bright yellow green; "CAUTION" E Mod; "OBSTRUCTION" D; "AHEAD" D;

"NO ACCESS" D 50% spacing;




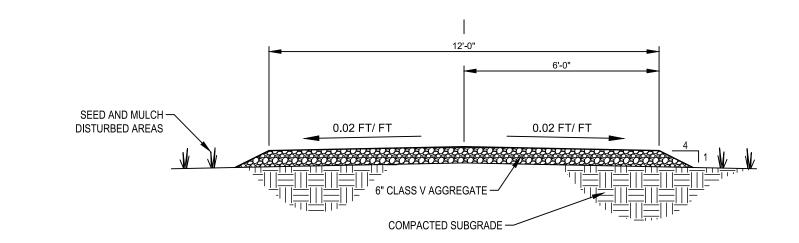



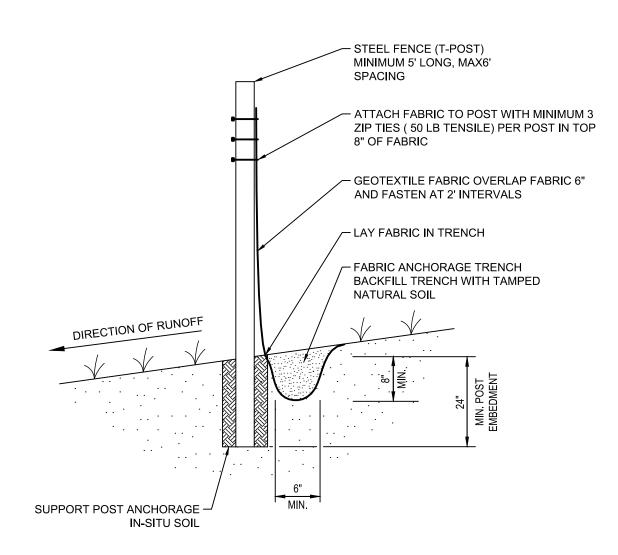



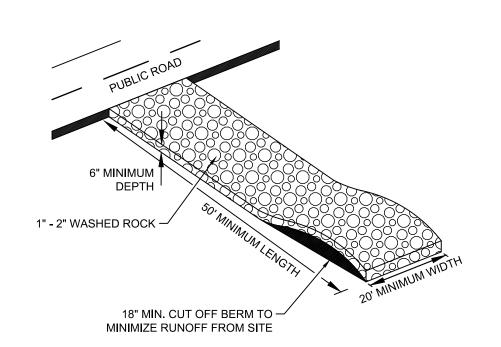

NOTE:

1. FILTER FABRIC SHALL BE PLACED UNDER ROCK TO STOP MUD MIGRATION THROUGH ROCK.

2. ENTRANCE MUST BE MAINTAINED TO PREVENT SEDIMENTATION ON PUBLIC ROADWAYS. FUGITIVE ROCKS WILL BE REMOVED FROM ADJACENT ROADWAYS DAILY OR MORE FREQUENTLY AS NECESSARY.





FAX: 952-831-1268 WWW.WENCK.COM

MINNEHAHA CREEK WATERSHED DISTRICT QUALITY OF WATER, QUALITY OF LIFE



AKE AUBURN ARP BARRIER

NO ISSUE#

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LICENSE NO.:

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MJK ERM CJM

ISSUE DATE: DATE

ISSUE#

ISSUE NO.:
SHEET TITLE:

SHEET TITLE:

DETAILS

C-801

APPROXIMATE WEIGHTS - 6' LONG w/ CHANNELS

- 2-6' LONG CHORDS = 12' x 2.16 LBS/FT = 26 LBS
- 23-4' LONG SPINDALS = 92' x 1.44 LBS/FT = 133 LBS
- TOTAL WEIGHT = 159 LBS

CONCRETE:

- fc = 4,000 PSI
- **AIR CONTENT = 5% 7%**

REINFORCEMENT:

- ASTM A615 GRADE 60
- fy = 60,000 PSI
- **CLEAR COVER = 3"**

ALUMINUM SECTIONS:

6061-T6

STEEL SECTIONS:


- HOT DIPPED GALVANIZED
- YIELD STRENGTH 50 KSI

LIFTING MECHANISM:

- MECHANISM IS TO CONSIST OF A PULLEY SYSTEM
- MECHANSIM IS TO HAVE A 225 LB LIFTING WEIGHT CAPACITY
- MECHANISM IS TO BE ABLE TO LOCK IN PLACE AT VARIOUS LIFTING HEIGHTS
- MECHANISM IS TO BE ABLE TO BE OPERATED FROM SHORELINE

BARRIER & LIFTING MECHANISM SECURITY:

- BARRIERS ARE TO HAVE THE CAPABILITY TO BE SECURELY LOCKED IN-PLACE TO PREVENT STEALING AND VANDALISM IN BOTH DOWN AND UP POSITIONS.
- LIFTING MECHANISM IS TO HAVE THE CAPABILITY TO BE SECURELY LOCKED IN-PLACE TO PREVENT STEALING AND VANDALISM.

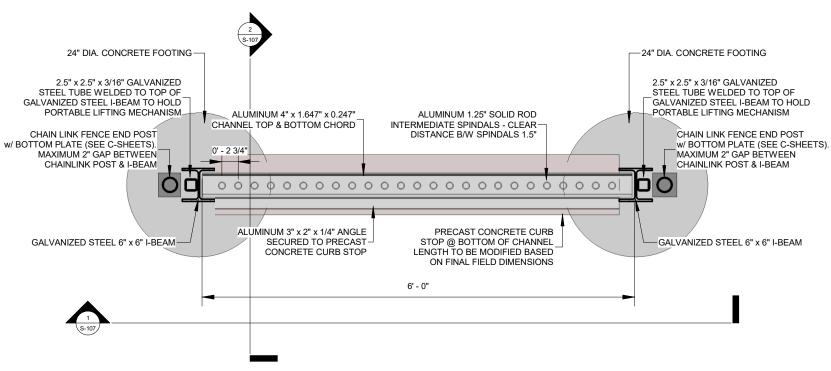

I HEREBY CERTIFY THAT THIS PLAN. SPECIFICATION.

REPORT WAS PREPARED BY ME OR UNDER MY DIRECT SUPERVISION AND THAT I AM A DULY LICENSED PROFESSIONAL ENGINEER UNDER THE LAWS OF THE STATE OF MINNESOTA

MPJ TNT Add split gate to barrier DATE: 10/4/2018 REVISION DESCRIPTION DWN CENSE NUMBER 15051

Responsive partner. Exceptional outcomes.

1012 5th AVE., Suite 1B WINDOM, MN 56101 507-831-2703

SCALE 3/4" = 1'-0"

CHK'D APP'D PROJECT DWN BY DJJ DJJ SIX MILE CREEK CARP BARRIERS MPJ DWG DATE CLIEN Minnehaha Creek Watershed District 10/2/2018 15320 Minnetonka Blvd

2" x 2" x 3/16" GALVANIZED STEEL

2.5" x 2.5" x 3/16" GALVANIZED STEEL TUBE WELDED TO TOP OF

GALVANIZED STEEL 6" x 6" I-BEAMS

3" x 2" x 1/4" ALUMINUM BOX SECURED TO PRECAST-

CONCRETE CURB STOP

GALVANIZED STEEL I-BEAM TO HOLD PORTABLE LIFTING MECHANISM

GALVANIZED STEEL I-BEAM SET INTO CONCRETE FOOTING A MINIMUM OF 5 FEET

PORTABLE TUBE w/ PULLEY SYSTEM ATTACHED TO THE TOP

> SHEET PLAN VIEW - HIGHLAND Plan & ISO View- Lake Auburn

2" x 2" x 3/16" GALVANIZED STEEL

SYSTEM ATTACHED TO THE TOP

2.5" x 2.5" x 3/16" GALVANIZED

STEEL TUBE WELDED TO TOP OF GALVANIZED STEEL I-BEAM TO HOLD

GALVANIZED STEEL I-BEAM

PORTABLE LIFTING MECHANISM

PORTABLE TUBE w/ PULLEY

-CARP BARRIER

PROJECT NO. 0185-0100

SHEET NO. REV NO. S-106

1	Plan View - Lake Auburn Barrier 3/4" = 1'-0" AT 11" x 17" PAPER		
(・/	2/4" - 4' 0" AT 44" v 47" DADED		
_	3/4 - 1-0 ATTT X 1/ PAPER		
	3/4 - 1-0 ATTI XTI PAPER		


11/19/2019

REV DATE

APP

SET INTO CONCRETE FOOTING A MINIMUM OF 5 FEET 24" DIA. CONCRETE FOOTING--24" DIA. CONCRETE FOOTING Isometric View - Lake Auburn Barrier

Minnetonka, MN 55345

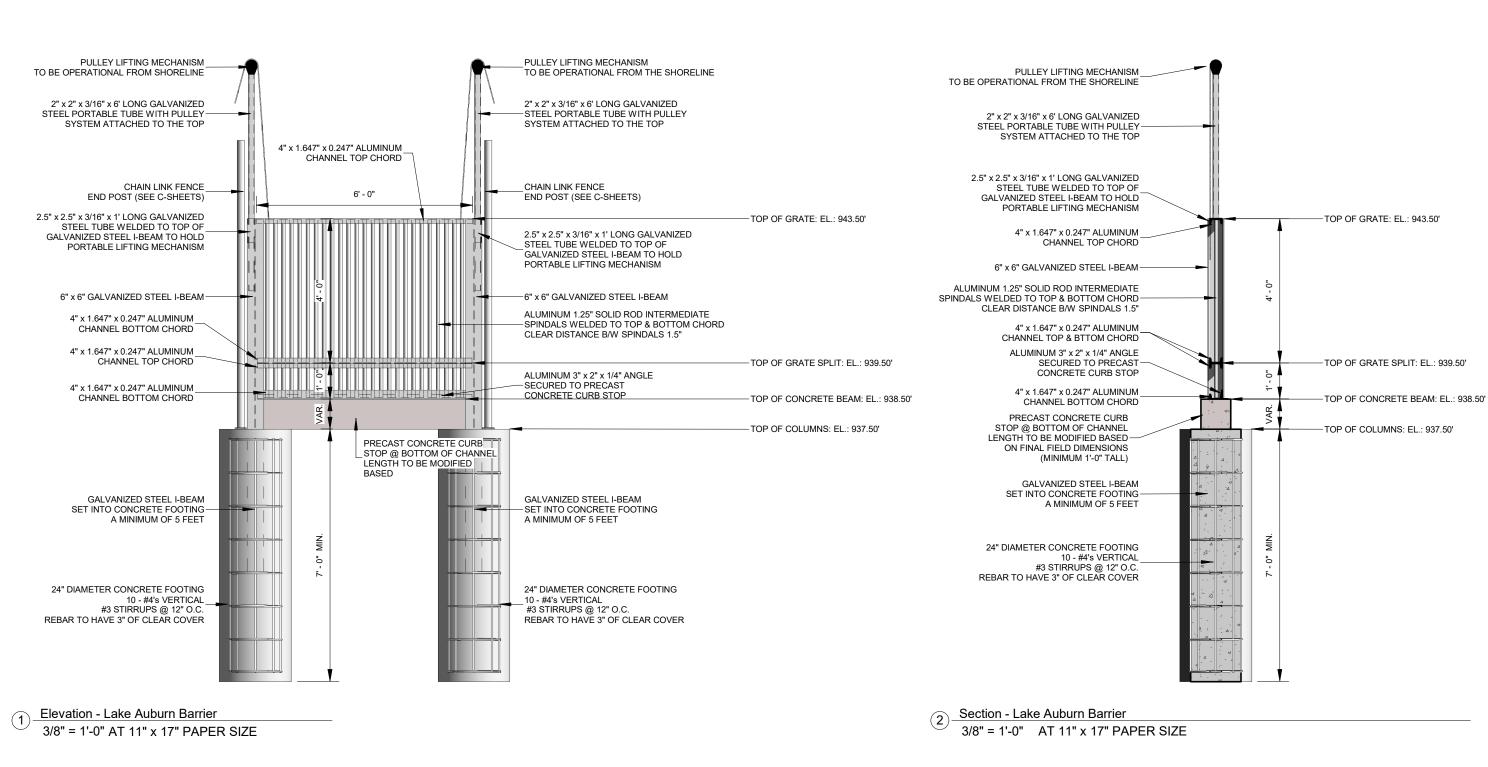

I HEREBY CERTIFY THAT THIS PLAN, SPECIFICATION, REPORT WAS PREPARED BY ME OR UNDER MY DIRECT SUPERVISION AND THAT I AM A DULY LICENSED DWN BY CHK'D APP'D PROJECT SHEET PROFESSIONAL ENGINEER UNDER THE LAWS OF THE TITLE DJJ SIX MILE CREEK CARP BARRIERS 1012 5th AVE., Suite 1B MPJ DJJ STATE OF MINNESOTA Lake Auburn Barrier Details WINDOM, MN 56101 DWG DATE 507-831-2703 Minnehaha Creek Watershed District 507-831-5271 PROJECT NO. SHEET NO. REV NO. 10/2/2018 DATE: 10/4/2018 Responsive partner. Exceptional outcomes. 15320 Minnetonka Blvd S-107 REVISION DESCRIPTION DWN APP **REV DATE** Minnetonka, MN 55345 0185-0100 SCALE 3/8" = 1'-0" CENSE NUMBER 15051